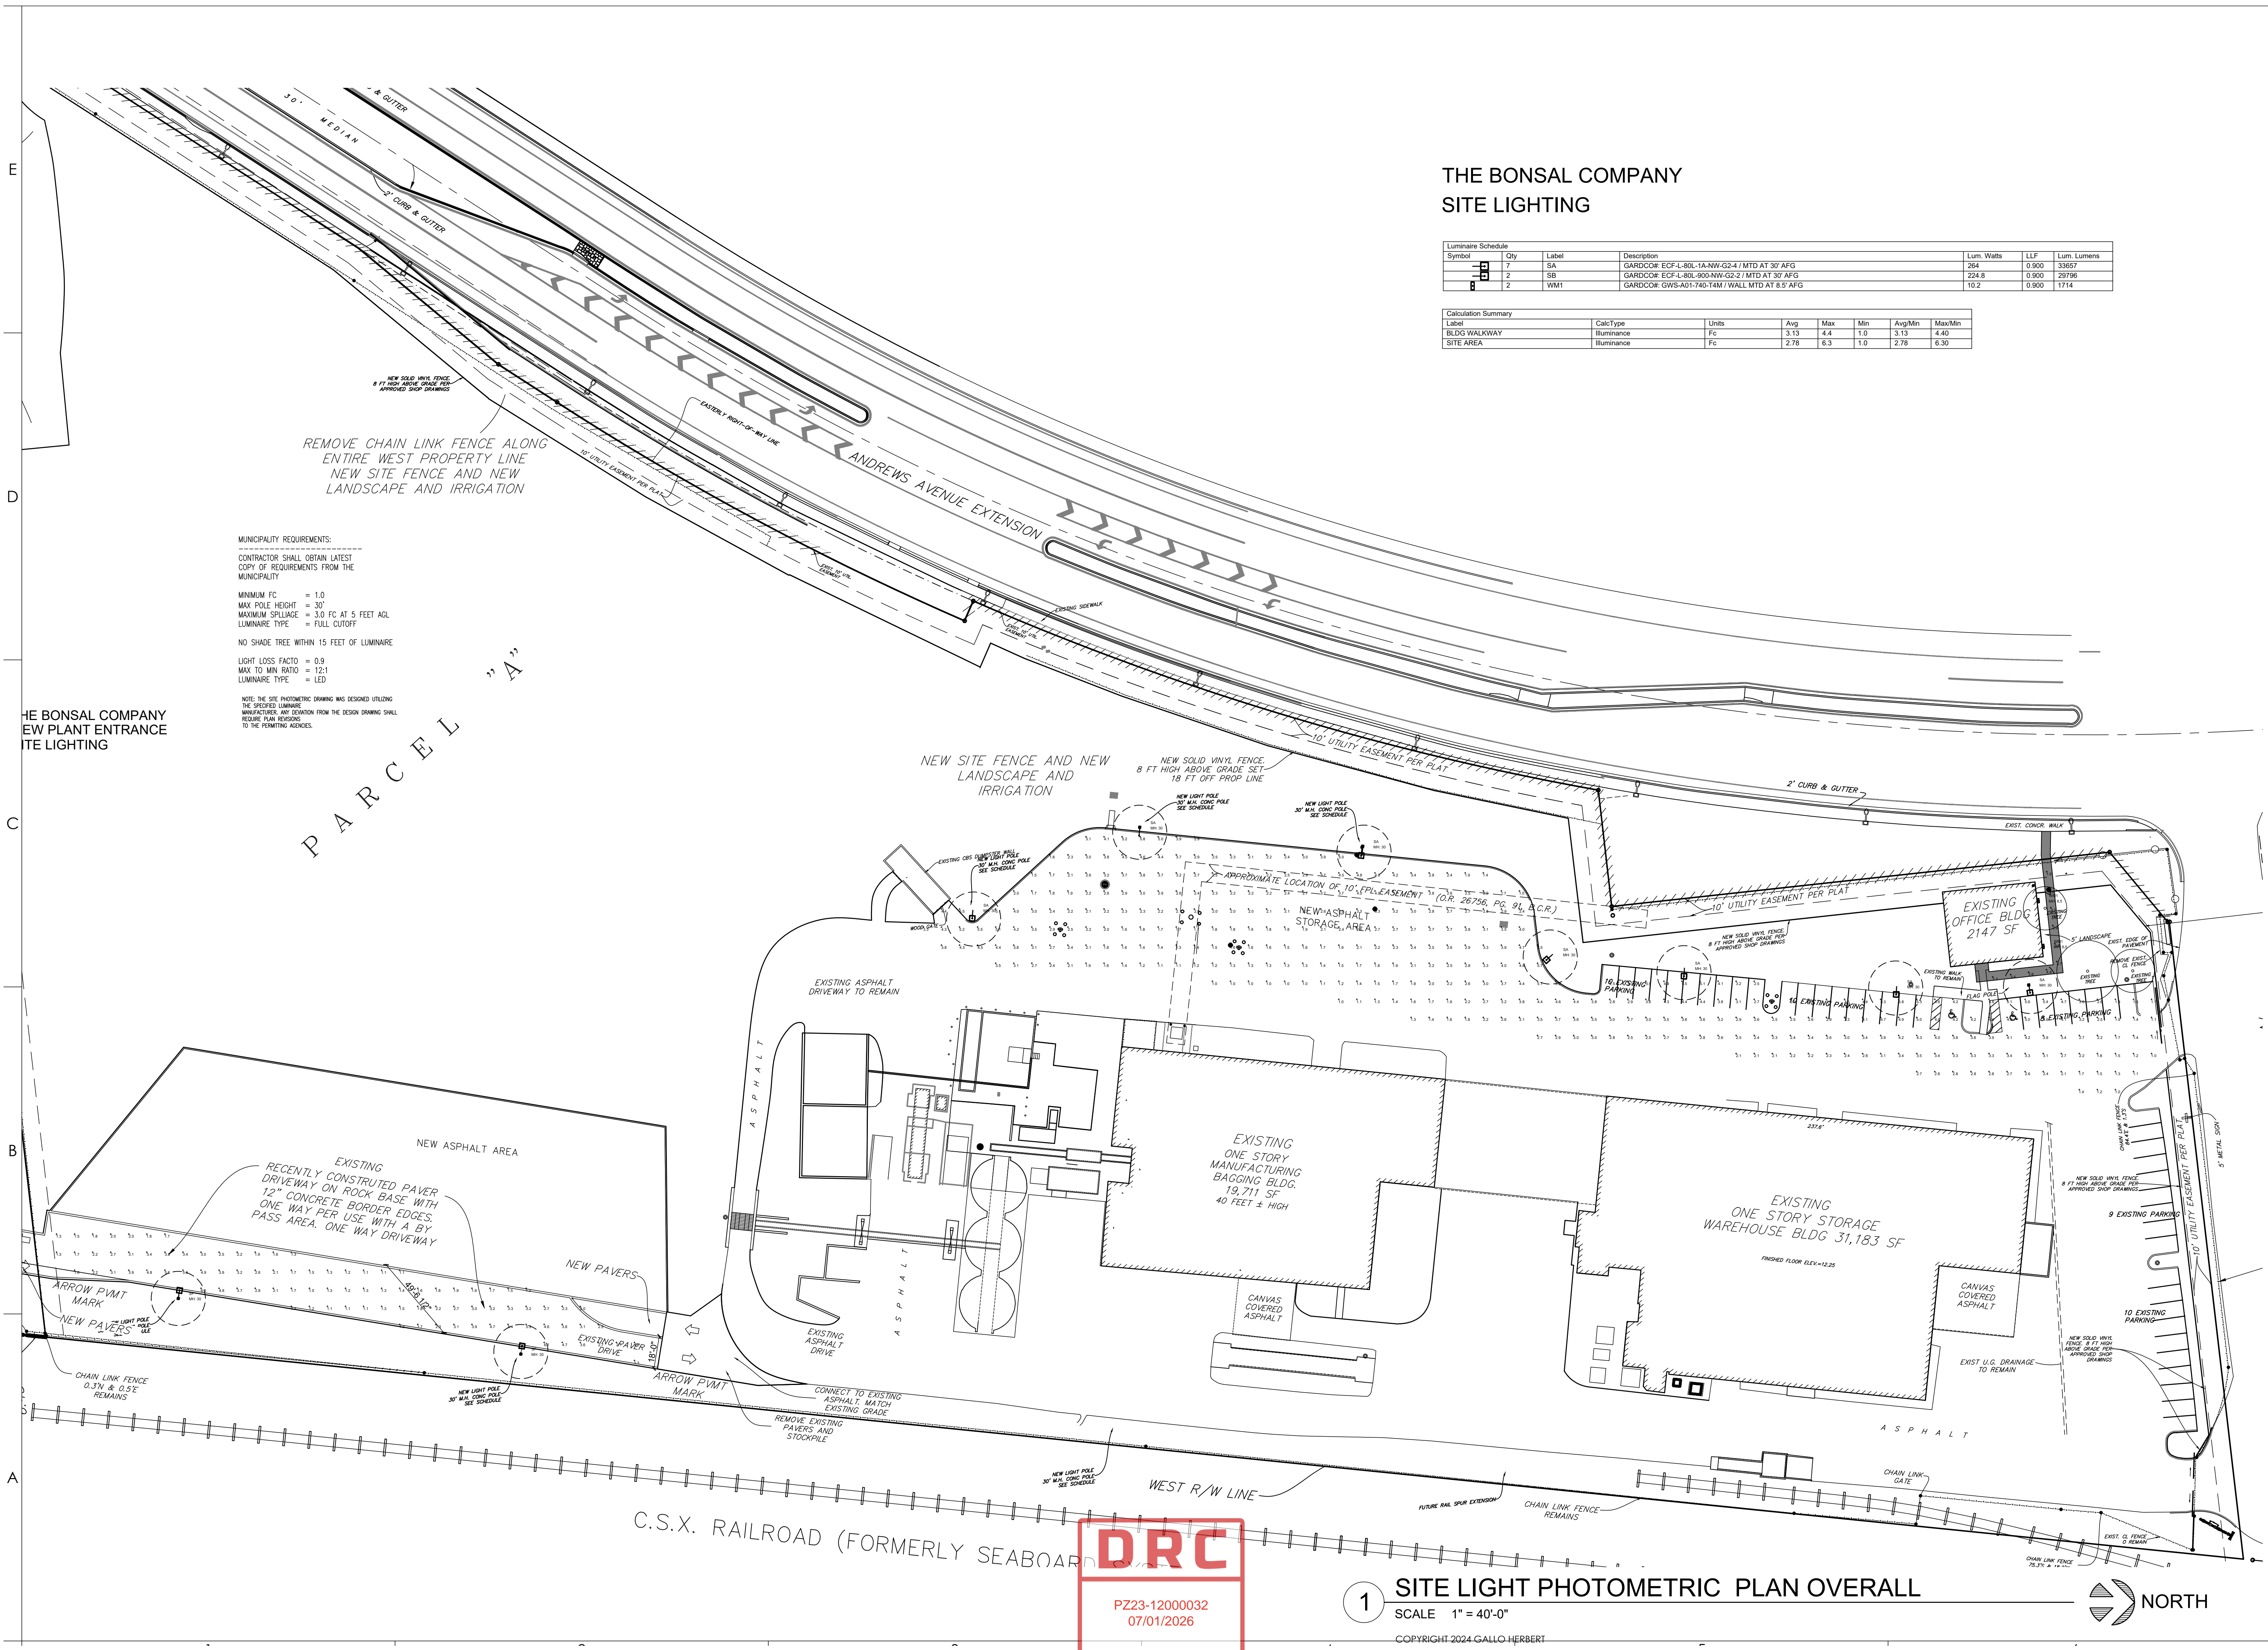


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THE BONSAI COMPANY SITE LIGHTING

Luminaire Schedule				Lum. Watts	LLF	Lum. Lumens
Symbol	Qty	Label	Description	264	0.900	33657
SA	7	SA	GARDCOR: ECF-L-80L-1A-NW-G2-4 / MTD AT 30' AFG	224.8	0.900	29796
SB	2	SB	GARDCOR: ECF-L-80L-900-NW-G2-2 / MTD AT 30' AFG	10.2	0.900	1714
WM1	2	WM1	GARDCOR: GWS-A01-740-T4M / WALL MTD AT 8.5' AFG			

Calculation Summary						
Label	CalcType	Units	Avg	Max	Min	MaxMin
BLDG WALKWAY	Illuminance	Fc	3.13	4.4	1.0	3.13 4.40
SITE AREA	Illuminance	Fc	2.78	6.3	1.0	2.78 6.30

MUNICIPALITY REQUIREMENTS:
 CONTRACTOR SHALL OBTAIN LATEST COPY OF REQUIREMENTS FROM THE MUNICIPALITY

MINIMUM FC = 1.0
 MAX POLE HEIGHT = 30'
 MAXIMUM SPALLAGE = 3.0 FC AT 5 FEET AGL
 LUMINAIRE TYPE = FULL CUTOFF
 NO SHADE TREE WITHIN 15 FEET OF LUMINAIRE

LIGHT LOSS FACTOR = 0.9
 MAX TO MIN RATIO = 12:1
 LUMINAIRE TYPE = LED

NOTE: THE SITE PHOTOMETRIC DRAWING WAS DESIGNED UTILIZING THE SPECIFIED LUMINAIRE MANUFACTURER. ANY DEVIATION FROM THE DESIGN DRAWING SHALL REQUIRE PLAN REVISIONS TO THE PERMITTING AGENCIES.

THE BONSAI COMPANY
 EW PLANT ENTRANCE
 ITE LIGHTING

PARCEL "A"

GHA
 GALLO HERBERT ARCHITECTS
 1311 W NEWPORT CENTER DRIVE, DEERFIELD BEACH, FLORIDA 33442 PH. 954.794.0300 F.X. 954.794.0301

AA26001731
 [SEAL]
 WILLIAM J. GALLO FL AR0008440

BRIAN P. HERBERT FL AR0015474
 [PROJECT]

BONSAI SITE IMPROVEMENTS
 1200 NW 18TH ST
 POMPANO BEACH FL 33069

OWNER

REVISIONS		
No.	Description	Date
B	MINOR SITE SBMTL	07-19-2023
	MINOR SITE SBMTL	06-25-2024
	MINOR SITE SBMTL	09-30-2024
	DRC RESUBMITTAL	10-09-2024
	DRC RESUBMIT	12-18-2025
	DRC RESUBMIT	05-06-2026

PROJECT STATUS
 MINOR SITE PLAN SUBMITTAL

DATE

PROJECT NUMBER
 2123

SCALE
 AS SHOWN

DRAWN BY: [] CHECKED BY: JET

DRAWING TITLE
 SITE LIGHTING PHOTOMETRIC PLAN

DRAWING NUMBER
 SL-0 OVERALL

DRC

PZ23-12000032
 07/01/2026

1 SITE LIGHT PHOTOMETRIC PLAN OVERALL
 SCALE 1" = 40'-0"
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